Lockport-Batavia Line #112 Rebuild Project

Appendix Z

Grading Plans

June 2025 Case 22-T-0654

NIAGARA MOHAWK POWER CORPORATION D/B/A NATIONAL GRID LOCKPORT - BATAVIA 112 REBUILD PROJECT APPENDIX Z PSC CASE NO. 22-T-0654

SHEET NUMBER

GP-07-10

TITLE

national<mark>grid</mark>

GP-01 CC GP-02-03 SH GP-04 GF

GP-04 GRADING DRA
GP-05 LEGEND NOTE
GP-06 GRADING PLAN

COVER SHEET SHEET INDEX GRADING DRAWING INDEX LEGEND NOTES GRADING PLAN DETAILS GRADING PLANS

GRADING PLANS

ISSUED FOR PERMITTING



GRADING DRAWING INDEX				
DRAWING NUMBER	TITLE	ASSOCIATED EM&CP SHEET	DESCRIPTION	
GP-01	COVER	N/A		
GP-02	SHEET INDEX - A	N/A		
GP-03	SHEET INDEX - B	N/A		
GP-04	GRADING DRAWING INDEX	N/A		
GP-05	LEGEND - NOTES	N/A		
GP-06	D4-PAD	N/A		
GP-07	GRADING PLAN VIEW	41	CROSSING SE STRUCTURE #130	
GP-08	PROFILE VIEW	41	CROSSING SE STRUCTURE #130	
GP-09	GRADING PLAN VIEW	42	STRUCTURE #139 WORKPAD	
GP-10	PROFILE VIEW	42	STRUCTURE #139 WORKPAD	



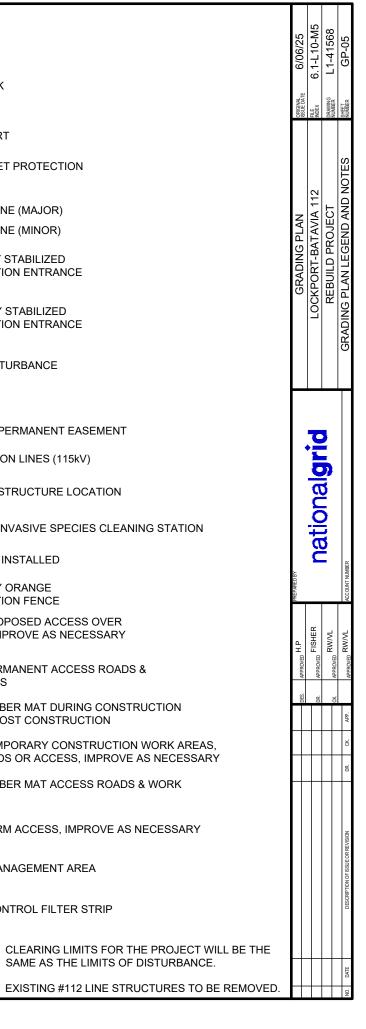
NOTES:

- 1. EROSION AND SEDIMENT CONTROL MEASURES TO BE UTILIZED ARE INCLUDED IN THE EM&CP DRAWINGS AND THE PROJECT STORMWATER POLLUTION PREVENTION PLAN (SWPPP). IN THE CASE OF CONFLICTS, THESE PLANS AND DIRECTION PROVIDED BY THE ENVIRONMENTAL MONITOR GOVERN.
- 1.1. SLOPES UP TO 3H:1V SHALL RECEIVE TOPSOIL (APPR. 3"-4" MIN.) SEED, AND MULCH, AND BE STABILIZED WITH EROSION CONTROL BLANKET.
- 1.2. SLOPES FROM 3H:1V TO 2H:1V SHALL RECEIVE TOPSOIL 1.2. (APPR. 3"-4") AND BE STABILIZED WITH HYDROSEED/HYDROMULCH.
- 1.3. SLOPES STÉEPER THAN 2H:1V SHALL BE STABILIZED WITH
- 2. FILTER BARRIERS APPROVED FOR USE INCLUDE SILT FENCE, COMPOST FILTER SOCKS, AND STRAW BALES. CONTRACTOR MAY SELECT METHOD UNLESS DIRECTED OTHERWISE BY THE ENVIRONMENTAL MONITOR.
- 3. UNLESS INDICATED OTHERWISE, REFER TO THE LATEST EDITION OF THE "NEW YORK STATE DEPARTMENT OF TRANSPORTATION STANDARD SPECIFICATIONS" FOR GENERAL REQUIREMENTS, PRODUCTS, AND EXECUTION RELATED TO CONSTRUCTION OF, BUT NOT LIMITED TO, GRUBBING, ROADS, BORROW, SUBGRADE, SUBBASE, GRANULAR FILL, AND AGGREGATED BASE.
- 4. RESTORATION OF GRADED AREAS: WHERE GRADING HAS OCCURRED, ALL AREAS WILL BE RESTORED TO A STABLE CONDITION WITH SLOPES NOT TO EXCEED 3:1.
- DERIVED FROM A TOPOGRAPHIC SURVEY PERFORMED BY FISHER ASSOCIATES IN AUGUST OF 2023. THE CONTRACTOR SHALL VERIFY THE ACCURACY PRIOR TO CONSTRUCTION.

EX	KISTING FEATURES
	PROPERTY COUNTY TAX MAP
300	CONTOUR LINE
TN	TOWN LINE
x	FENCE
——— он Е	OVERHEAD ELECTRIC
— U/E —— U/E —— U/E ——	UNDERGROUND ELECTRIC
G	UNDER GROUND GAS LINE
F 0	UNDER GROUND FIBER OPTIC
w	UNDER GROUND WATER
	UNDERGROUND PETROLEUM
ss	UNDERGROUND STORM SEWER
s	UNDERGROUND SANITARY SEWER
т	UNDERGROUND TELEPHONE
	NIAGARA MOHAWK POWER CORP. EXISTING PROPERTY LINES
	NIAGARA MOHAWK POWER CORP. EXISTING EASEMENT LIMITS
	NIAGARA MOHAWK POWER CORP. LEGACY PROPERTY LINES
	PARK BOUNDARY LINE
	ADJOINER PROPERTY LINES
235.12-1-31	TAX MAP IDENTIFICATION NUMBER (S.B.L)
LOCKPORT-BATAVIA #112	SUB-TRANSMISSION & TRANSMISSION LINES
MICHAEL ROGERS L&T NO. 119-L-7	NIAGARA MOHAWK CORP. L&T DOCUMENT NUMBER
+	WOOD POLES
I	FLEX TOWERS
	SQUARE BASE TOWERS
\triangle	3 LEGGED TOWERS
-	GUY WIRES
====	CULVERT
+	PULL BOX
F	LINE MARKER
•	BOLLARDS
	DITCH
STREAM 1, CLASS C	STREAM CENTERLINE, I.D. NUMBER CLASS
::=	STREAM BANK, I.D. NUMBER & CLASS
	DEC WETLAND
	DEC WETLAND 100' ADJACENT AREA
	DELINEATED WETLANDS
	WATER BODY
	FEMA FLOODPLAIN



SYMBOLS SHOWN HERE MAY BE LARGER OR SMALLER THEN REPRESENTED ON DETAILED DRAWING.



PROPOSED FEATURES

00

SILT FENCE

FILTER SOCK

BOX CULVERT

ROCK OUTLET PROTECTION

CONTOUR LINE (MAJOR)

CONTOUR LINE (MINOR)

PERMANENT STABILIZED

TEMPORARY STABILIZED

LIMIT OF DISTURBANCE

CONSTRUCTION ENTRANCE

PROPOSED PERMANENT EASEMENT

PROPOSED STRUCTURE LOCATION

TYPE 1 - PROPOSED ACCESS OVER EXISTING, IMPROVE AS NECESSARY

PERVIOUS POST CONSTRUCTION

WILDLIFE MANAGEMENT AREA

EROSION CONTROL FILTER STRIP

TYPE 2 - PERMANENT ACCESS ROADS &

TYPE 3 - TIMBER MAT DURING CONSTRUCTION

TYPE 5 - TIMBER MAT ACCESS ROADS & WORK

TYPE 6 - BERM ACCESS. IMPROVE AS NECESSARY

SAME AS THE LIMITS OF DISTURBANCE.

TYPE 4 - TEMPORARY CONSTRUCTION WORK AREAS. PULLING PADS OR ACCESS, IMPROVE AS NECESSARY

PROPOSED INVASIVE SPECIES CLEANING STATION

TRANSMISSION LINES (115kV)

GATE TO BE INSTALLED

TEMPORARY ORANGE CONSTRUCTION FENCE

WORK AREAS

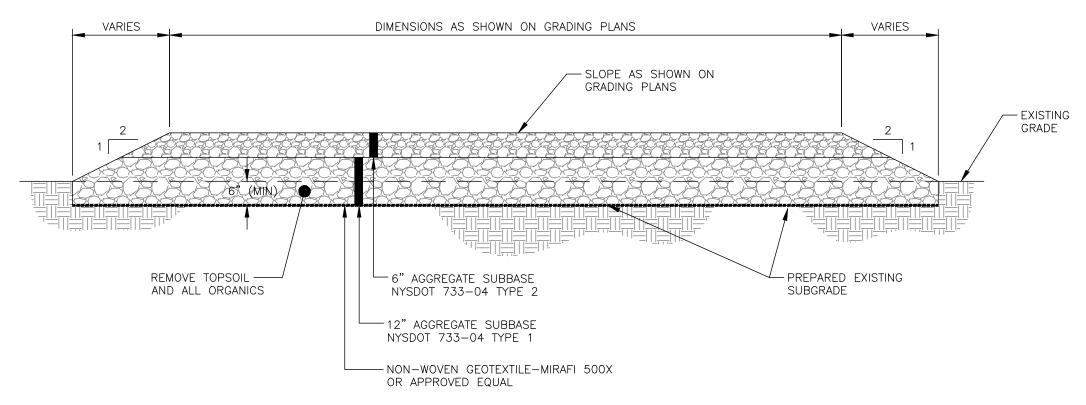
AREAS

CONSTRUCTION ENTRANCE

CULVERT

DITCH

FENCE



CONSTRUCTION PAD NOTES:

1. DELINEATE LIMITS OF DISTURBANCE AND INSTALL EROSION & SEDIMENT CONTROL BMPs AS SHOWN ON PLAN AND DIRECTED BY ENGINEER OR ENVIRONMENTAL MONITOR.

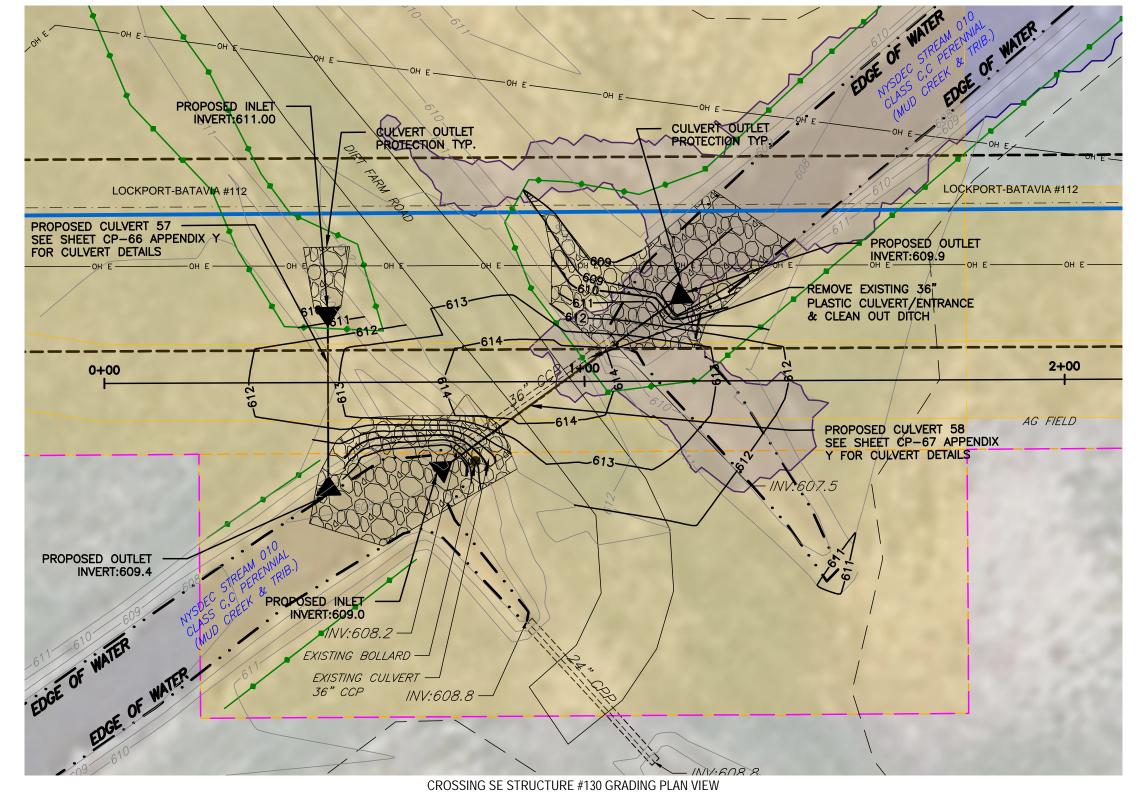
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- 2. STRIP TOPSOIL AND ORGANICS (±6 INCHES). STOCKPILE TOPSOIL FOR FINAL SITE RESTORATION. REMOVE ALL SOFT, ORGANIC OR OTHER UNACCEPTABLE MATERIAL FROM THE SUBGRADE AND REPLACE WITH SELECT GRANULAR SUBGRADE, NYSDOT 733-1302.
- 3. COMPACT THE TOP SIX (6) INCHES OF SUBGRADE TO 95% MAXIMUM DRY DENSITY (MINIMUM) PER ASTM D1557. DURING COMPACTION THE SUBGRADE SHALL BE AT MINUS 3 TO PLUS 2 PERCENT (-3% TO +2%) OF THE OPTIMUM MOISTURE CONTENT.
- 4. INSTALL GEOTEXTILE IN ACCORDANCE WITH MANUFACTURER'S RECOMMENDATIONS.**
- 5. PLACE AGGREGATE SUBBASE IN MAXIMUM 12" LIFTS (LOOSE). GRADE AND COMPACT TO 95% MAXIMUM DRY DENSITY.
- ** GEOTEXTILE NOT REQUIRED IN CONSTRUCTION PADS IDENTIFIED AS "IMPROVE AS NECESSARY"

PROPOSED GRAVEL WORK AREA

(NOT TO SCALE)

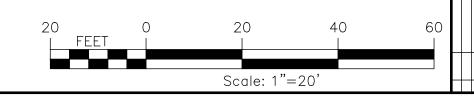




HORIZ: 1" = 20'

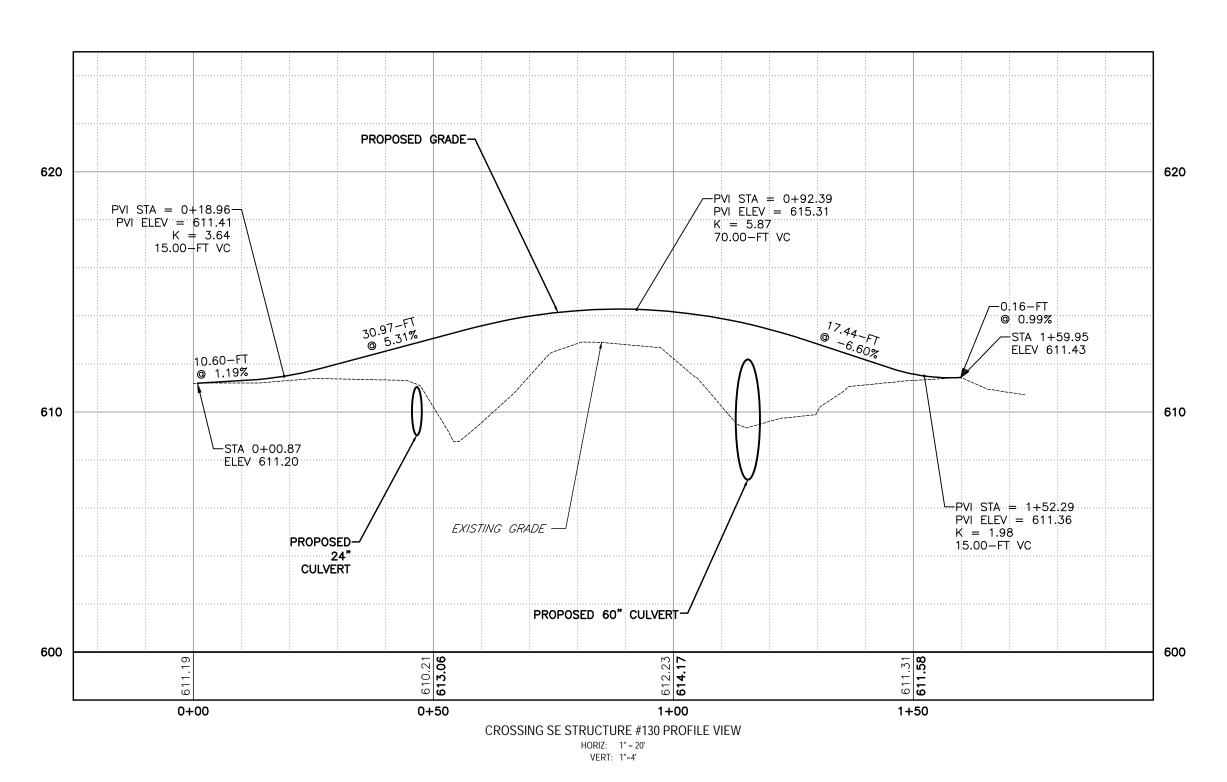
- 1. SEE SHEET GP-04 FOR LEGEND.
- GRADING /DISTURBANCE SHALL BE CONFINED TO THE LIMITS SHOWN.
 INSTALL EROSION AND SEDIMENT CONTROLS AS SHOWN AT THE DIRECTION OF THE ENVIRONMENTAL MONITOR.
 - EXCAVATED SOILS ACCEPTABLE FOR USE AS COMMON FILL.
- RESTORE WORK PAD AREAS TO A STABLE CONDITION ONCE CONSTRUCTION IS COMPLETE.
- 6. POST-CONSTRUCTION SLOPE STABILIZATION:
- a. SEED AND MULCH TO SLOPE AND STABILIZE STREAM BANKS WITH EROSION CONTROL BLANKET OR RIPRAP.

 7. RESTORATION OF GRADED AREAS: WHERE GRADING HAS OCCURRED, ALL AREAS WILL BE RESTORED TO A STABLE
- CONDITION WITH SLOPES NOT TO EXCEED 3:1.

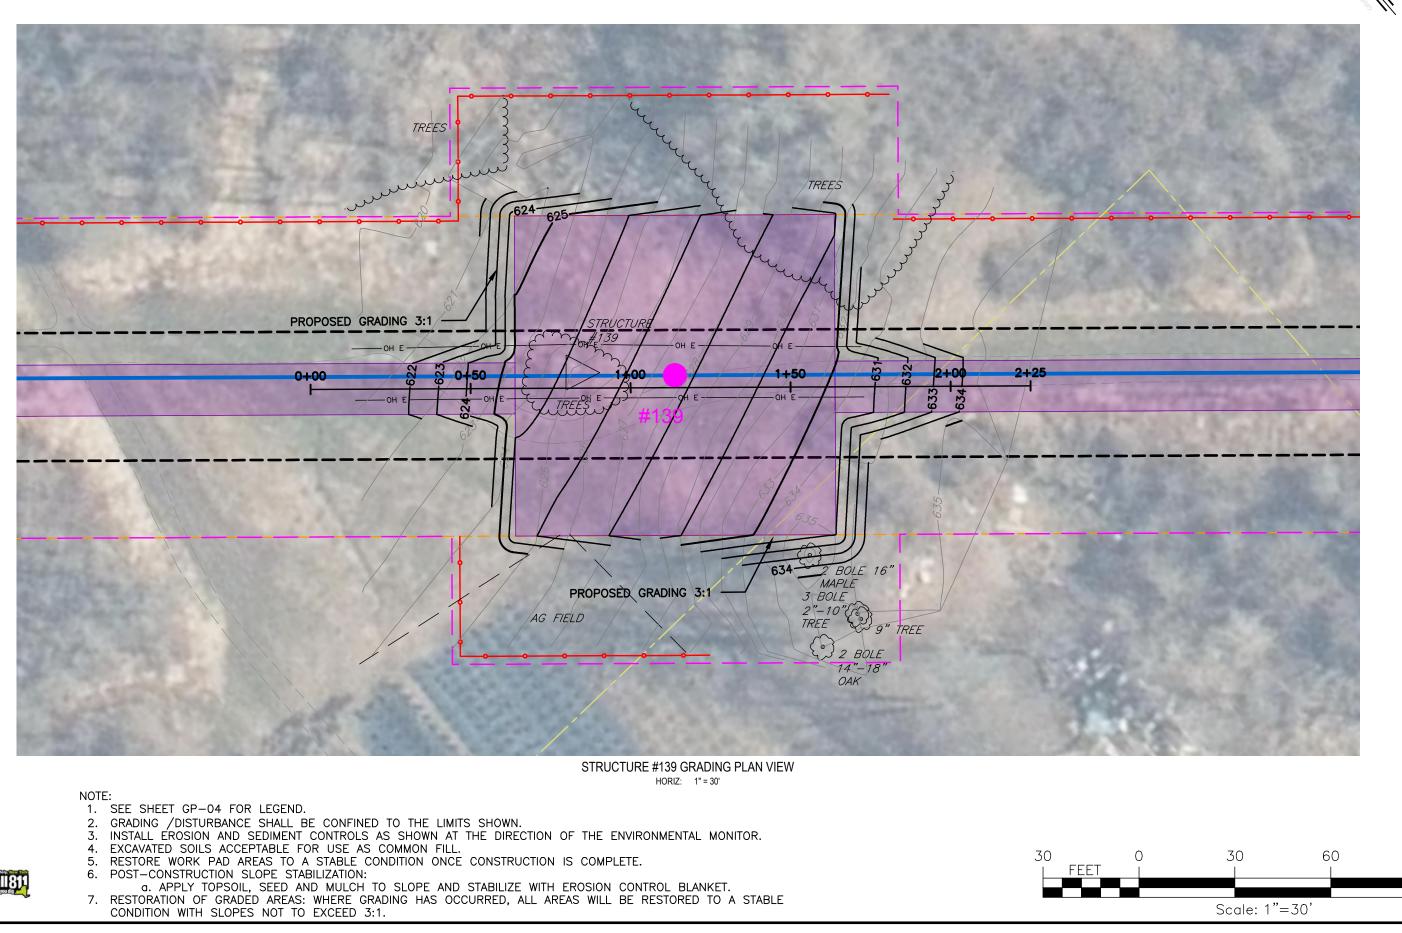


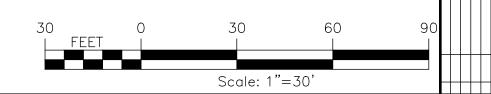
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Scale: 1"=20'

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